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Civic Centre, Berg River Boulevard, Paarl 7647

Enquiries: Cornelia vd Bank Contact number: 021 807 4832 Reference: (15/4/1 –3432) P Date: 06 August 2025

Cvd Bank/HK

Iana Jordaan FRAME 277 Main Road PAARL 7620

Email: iana.jordaan@framegroup.co.za

Madam

APPLICATION FOR THE REZONING, PERMANENT DEPARTURE AND APPROVAL OF A SITE DEVELOPMENT PLAN FOR ERF 3432 PAARL

I refer to your land use application (collaborator reference 2255828).

- 1. Provisional approval is hereby granted in terms of Section 60(1)(a) of the Bylaw on Municipal Land Use Planning, 2018, for the following:
 - 1.1 The **Rezoning** of Erf 3432 Paarl from "Conventional Housing Zone" to "Neighbourhood Business Zone" to allow the existing buildings to be used for offices.
 - 1.2 The **Permanent Departure** of the common boundary line restrictions as indicated on the Site Development Plan, drawn by Arch on Main, (Drawing No 4172-00 dated 6 May 2025) (**Annexure B**).
- 2. That permission be granted in terms of Section 17 of the Zoning Bylaw 2018, for:
 - 2.1 The provision of on-site parking within 10m of the street boundary.
 - 2.2 The re-development of the existing building for offices within the Paarl Central Special Character Protected Area Overlay Zone.
 - 2.3 The re-development of property affected by the Road Widening Overlay Zone along Main Road.

- 3. The approvals granted in above mentioned paragraphs shall be subject to the following conditions, laid down in terms of Section 66 of the Drakenstein Bylaw on Municipal Land Use Planning, 2018:
 - 3.1 Adherence to the conditions laid down by the Drakenstein Municipality: Civil Engineering Services Division in its memorandum 15/4/1(3432)P(0980) dated 31 July 2025(Annexure D).
 - 3.2 Adherence to the conditions laid down by the Drakenstein Municipality: Electro Technical Services Division in its memorandum dated 11 March 2024 (Annexure E).
 - 3.3 Adherence to the conditions as set by Land Development Management:
 - 3.3.1 The development shall take place in accordance with the Site Development Plan (Annexure B).
 - 3.3.2 The applicant shall be responsible for the submission of any signage to the Drakenstein Heritage Advisory Committee for comments prior to it being displayed along Main Road.
 - 3.3.3 No buildings or structures may be erected, or existing structures altered, without the approval of building plans by Council; and
 - 3.3.4 Should the applicant fail to comply with the any of the abovementioned conditions of approval, the Council reserves the right to impose further conditions in future if deemed necessary.
- 4. That the following be regarded as the reasons for the decision:
 - 4.1 The application was administrated in terms of the Drakenstein Municipal Land Use Planning Bylaw, 2018 and notification was given to the surrounding property owners and residents of the estate as prescribed in terms of the mentioned legislation, to submit comments or objections.
 - 4.2 The proposed rezoning to "Neighbourhood Business" for offices will not have a negative impact on the amenity of the surrounding area.
 - 4.3 The existing historic building has been vacant and neglected for several years and requires significant maintenance and repair.
 - 4.4 The existing historic buildings will be internally reconfigured for office purposes subject to approval from Heritage Western Cape.
 - 4.5 The application was circulated to various internal and external departments for comment and consideration. No objections to the proposed subdivision were received.

- 4.6 The Civil Engineering Services Departments scrutinized the detail of supporting engineering studies for the application from roads and stormwater, potable water, wastewater and refuse removal point of view and concluded that there is sufficient capacity in the said municipal infrastructure to accommodate the proposed development.
- 4.7 The proposal conforms to the Spatial Planning Principles, SDF, and policies for the area.

Your attention is drawn to the general right of appeal to the Executive Mayor being the Appeal Authority in terms of Section 79(3) of the Drakenstein Bylaw on Municipal Land Use Planning, 2018, by any person whose rights are affected by the decision, within **21 days** of notification of decision.

The applicant shall be required to notify (by email or per hand) the <u>surrounding property</u> <u>owners</u> who were notified of the application during the initial public participation process and <u>objectors</u>, of their right of appeal – proof of notification <u>must</u> be provided.


Should there be any appeals against the decision, the application title (heading) must be used as reference. The appeal procedures are set out in Section 80 of the above-mentioned bylaw (attached).

Your attention is drawn to the fact that all correspondence must be directed to the City Manager and also sent via our official email address.

Yours faithfully

H. G. STRIJDOM (PR. PLN A/1058/1998)

MANAGER: LAND DEVELOPMENT MANAGEMENT

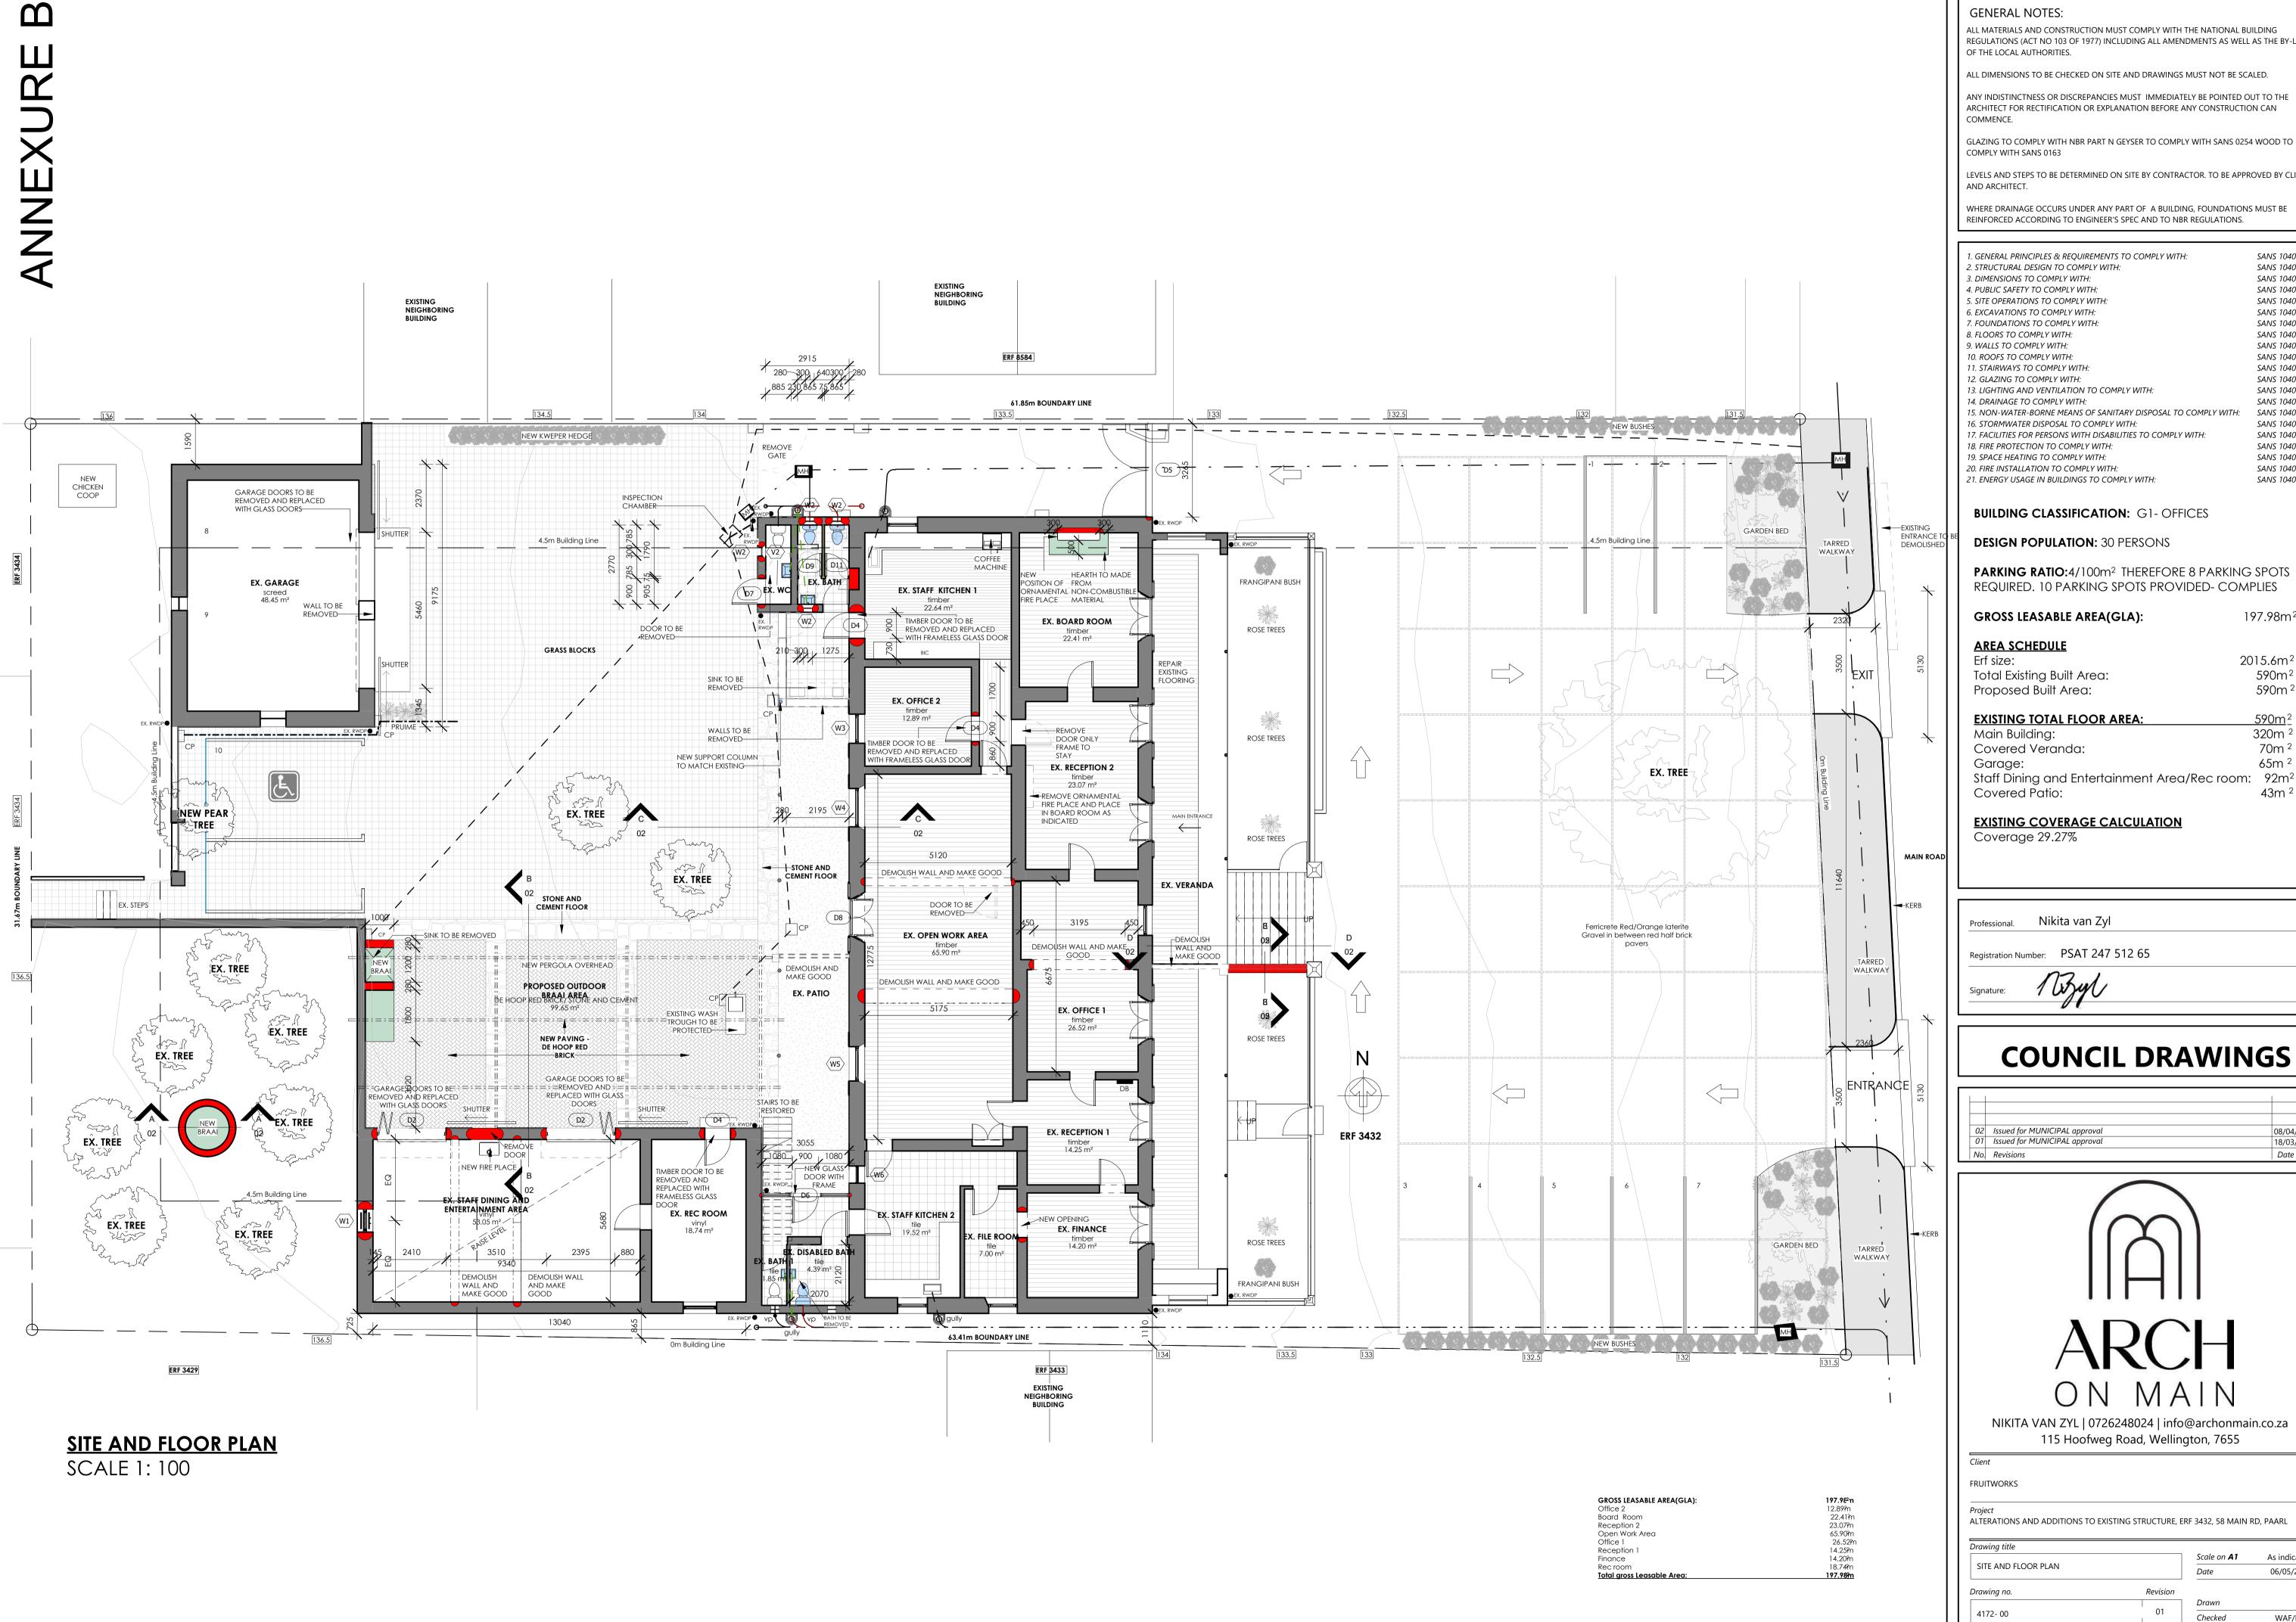

ALL MATERIALS AND CONSTRUCTION MUST COMPLY WITH THE NATIONAL BUILDING REGULATIONS (ACT NO 103 OF 1977) INCLUDING ALL AMENDMENTS AS WELL AS THE BY-LAWS

ALL DIMENSIONS TO BE CHECKED ON SITE AND DRAWINGS MUST NOT BE SCALED.

ANY INDISTINCTNESS OR DISCREPANCIES MUST IMMEDIATELY BE POINTED OUT TO THE ARCHITECT FOR RECTIFICATION OR EXPLANATION BEFORE ANY CONSTRUCTION CAN

GLAZING TO COMPLY WITH NBR PART N GEYSER TO COMPLY WITH SANS 0254 WOOD TO

LEVELS AND STEPS TO BE DETERMINED ON SITE BY CONTRACTOR. TO BE APPROVED BY CLIENT

WHERE DRAINAGE OCCURS UNDER ANY PART OF A BUILDING, FOUNDATIONS MUST BE REINFORCED ACCORDING TO ENGINEER'S SPEC AND TO NBR REGULATIONS.

1. GENERAL PRINCIPLES & REQUIREMENTS TO COMPLY WITH: SANS 10400-A SANS 10400-B SANS 10400-C SANS 10400-D SANS 10400-F SANS 10400-G SANS 10400-H SANS 10400-J SANS 10400-K SANS 10400-L SANS 10400-M SANS 10400-N SANS 10400-O SANS 10400-P 15. NON-WATER-BORNE MEANS OF SANITARY DISPOSAL TO COMPLY WITH: SANS 10400-Q SANS 10400-R 17. FACILITIES FOR PERSONS WITH DISABILITIES TO COMPLY WITH: SANS 10400-S SANS 10400-T SANS 10400-V SANS 10400-W SANS 10400-XA

PARKING RATIO:4/100m² THEREFORE 8 PARKING SPOTS REQUIRED. 10 PARKING SPOTS PROVIDED- COMPLIES

2015.6m² 590m² 590m²

197.98m²

320m² 70m ² 65m ²

COUNCIL DRAWINGS

08/04/2025 18/03/2025 Date



NIKITA VAN ZYL | 0726248024 | info@archonmain.co.za


As indicated

06/05/2025

WAF/NVZ

Scale on **A1**

01 Checked

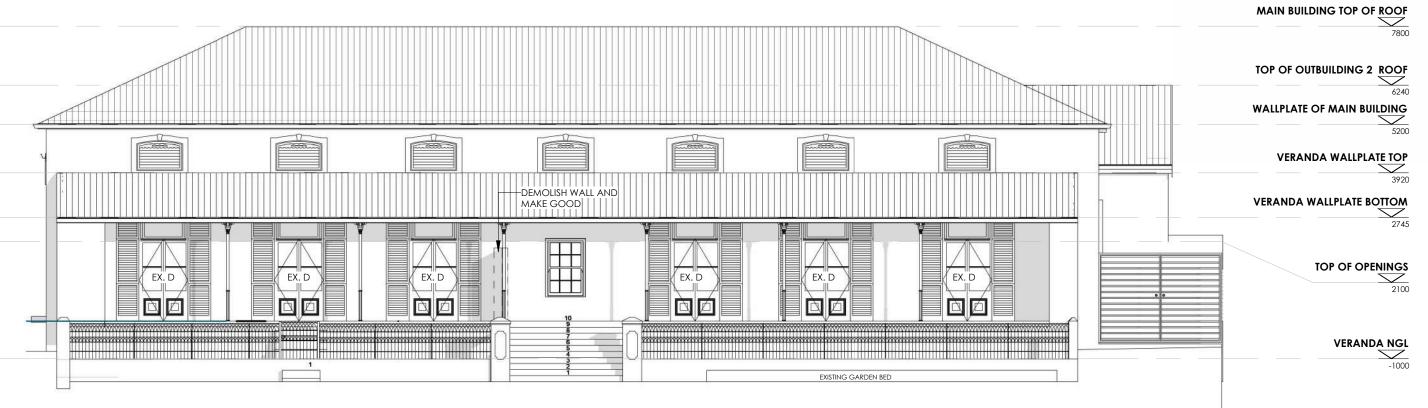

SCALE 1: 100

WEST ELEVATION OF OUTBUILDING 2

comply with Part V of SANS 10400. Chimney height to be a min 1000mm above roof construction **TOP OF ROOF OUTBUILDING 1** EXISTING ROOF **WALLPLATE OUTBUILDING 1** OUTBUILDING 1 ATTIC FFL

Ex. Sliding Garage doors to be removed and

eplaced with new shuttters lueell

SOUTH ELEVATION OF OUTBUILDING 1 SCALE 1: 100

SAN	NITARY FIXTUI	RES
	REQUIRED	PROVIDED
	MALE	
Toilet pans	1	2
Urinals	2	1
Wash-hand basins	2	2
	FEMALE	
Toilet pans	3	3
Wash-hand basins	2	2



EXISTING ROOF WALLPLATE OF MAIN BUILDING Existing parapet wall to be demolished and replaced VERANDA WALLPLATE TOP VERANDA WALLPLATE BOTTOM NEW ROOF 1 - SEE NOTES Note Shutter to be added to WEST ELEVATION OF MAIN BUILDING SCALE 1: 100

EAST ELEVATION OF MAIN BUILDING

SCALE 1: 100

PROPOSED WINDOW SCHEDULE	U/S OF LINTEL 795 S61 O012		510, 510, 92, 21	1340 0862	540	300 300	Existing window sizes to be confirmed on site before installati of new shutters
WINDOW No.	W1	W2	W3	W4	W5	W6	
DESCRIPTION	TIMBER SASH WINDOW WITH FIXED PANES TIMBER TO MATCH EXISTING	TIMBER TO MATCH EXISTING	TIMBER SHUTTERS FOR EXISTING WINDOWS SHUTTERS TO MATCH EXISTING IN DESIGN AND COLOUR	TIMBER SHUTTERS FOR EXISTING WINDOWS SHUTTERS TO MATCH EXISTING IN DESIGN AND COLOUR	TIMBER SHUTTERS FOR EXISTING WINDOWS SHUTTERS TO MATCH EXISTING IN DESIGN AND COLOUR	TIMBER SHUTTERS FOR EXISTING WINDOWS SHUTTERS TO MATCH EXISTING IN DESIGN AND COLOUR	
GLAZING	TO SANS 204A &10400 XA REGULATIONS	TO SANS 204A &10400 XA REGULATIONS	N/A	N/A	N/A	N/A	
No. REQUIRED	1	3	1	1	1	1	
TOTAL GLAZED AREA PER UNIT	0.4m ²	0.2m ²	N/A	N/A	N/A	N/A	

PROPOSED DOOR SCHEDULE	1750 1750	2395		2100	3265	3055 1000 1050 1000 F F 8 27		550 650 650 650 650 650 650 650 650 650
DOOR No.	DI	D2	D3	D4	D5	D6	D7	D8
DESCRIPTION	EXTERIOR ENTRANCE SOLID TIMBER DOOR TIMBER TO BE MATCH EXISTING	FRAMELESS EXTERIOR STACKING TO BE 8mm TEMPERED SAFETY GLAZING AND BARN STYLE TRACK SYSTEM BY SPECIALIST	BARN STYLE TRACK SYSTEM BY SPECIALIST	FRAMELESS DOOR TO BE 8mm TEMPERED SAFETY GLAZING BY SPECIALIST	EXTERIOR ENTRANCE DOUBLE GATE WITH ALUMINUM FRAME AND TIMBER SLATS ALUMINUM TO BE POWDER COATED CHARCOAL/ TIMBER TO BE WHITE	FRAMELESS DOOR TO BE 8mm TEMPERED SAFETY GLAZING BY SPECIALIST AND FIXED GLASS PANES	SOLID EXTERIOR TIMBER DOOR TO MATCH EXISTING	TIMBER SHUTTERS FOR EXISTING WINDOWS SHUTTERS TO MATCH EXISTING IN DESIGN AND COLOUR
GLAZING	N/A	TO SANS 204A &10400 XA REGS	N/A	TO SANS 204A &10400 XA REG	S N/A	TO SANS 204A &10400 XA REGS	TO SANS 204A &10400 XA REG	S N/A
No. REQUIRED	1	2	1	3	1	1	1	1
TOTAL GLAZED AREA PER UNIT	N/A	3.2m ²	N/A	2.15m ²	N/A	3.7m ²	0.6m ²	N/A

MAIN BUILDING TOP OF ROOF

GENERAL NOTES:

FILLING MATERIAL: Filling materials under floor slabs to consist of suitable material and to be compacted in layers of max. 150mm thick, to be a density of at least 90%MOD AASHTO

FOUNDATIONS:

TOP OF OUTBUILDING 2 ROOF

Concrete in 1:3:6 mix to sizes as shown on drawings. Cement to be SABS ENV 197-1 strength class 32.5 and aggregate to SABS specification 1083. Continuous strip foundation to be minimum 250mm thick, unless laid on solid rock and min 750mm wide to load bearing or free standing walls or 400mm wide for non-loadbearing internal masonry walls.

Floor finish as described elsewhere on 30mm 3:1 sand:cement screed on 100mm 1:2:4 concrete slab on 250micron membrane on consolidated fill for groundfloor. Floorslabs to be reinforced with BRC.245 weldmesh where depth of fill exceeds 1m. No ground floor slab to pass over or to be supported on foundation walls.

FLOOR DAMP PROOFING:

Under floor membrane to be Gunplus 250 micron membrane on 50mm sand blinding lay to be laid on surface not containing sharp objects and to be turned up around perimeter of and at least for full thickness of slab. Any joints will overlap 150mm min and will be effectively

All bricks to comply to with SABS 227. External walls to be 280mm cavity walls with plastered and painted bricks where indicated. Internal walls to be 115/230mm walls with plastered and painted bricks. Exterior walls to be painted

WALL DAMP PROOFING: Gunplas 375 micron to all walls stepped to outer skin of wall when a cavity wall. Wheepholes every 3rd brick. Vertical DPC to door, window cills and heads. No DPC to free standing walls.

Internal and external walls to receive smooth plaster finish.

Galvanized butterfly type every 4th course staggered at 1m c/c

STRESSO lintels over all openings exceeding 1.5m with damp proof membrane stepped ove Openings of more than 3.5m to be engineers's

designed. BRICK REINFORCEMENT: Use galvanized brick force in first 5 courses

above foundation and 5 courses continuous above lintel height.

ROOF SHEETING TO ENTIRE ROOF AREA: Safintra 0.50mm thick Saflok 410® Colorplus® AZ 150 interlocking roof sheeting fixed to steel internal purlins at 1700mm centres, and ridge/eaves purlins at 1500mm centres using Saflok 410® clips that must be fastened with Safintra approved wafer head self-tapping screws, all in accordance with manufacturer's recommendations. The sheeting will be a double interlocking concealed fix Saflok 410® as manufactured by Safintra, roll-formed in continuous lengths from Aluminum or Aluminum-Zinc coated steel. Colour to be dark

Roof 1: (Curved roof) 0.8 Corrugated Roof sheeting by Safintra or similar and approved to be curved matching

Trusses to be anchored min 760mm

front veranda to be supported by 75x 228 SA Pine rafter anchored to existing steel columns.

deep by $30 \times 1,2$ mm galvanized steel strap Ridge & side flashing to match colour of roof

135mm layer of Isotherm insulation or equivaler and approved to be applied to entire roof. Vapour barrier HF 2 aluminum foil sisilation or equivalent to be laid directly under the roof

Ceilings:
6.4mm Rhino-board ceiling, skimmed and painted on 50x38mm battens spaced max

450mm cc Detail of eaves to match existing dwelling.

Rainwater goods: Fascias and bargeboards to be 225 x12mm "Everite Nutec" or similar approved medium density fibre cement board with plain finish. butt jointed and painted with high quality acrylic paint to match the roof colour. Seamless "Watertite" Aluminum or similar, approved standard domestic Ogee gutters with round down pipes, powdercoated. "Everite" or similar approved plain fibre cement fascia,

Window & Doors: All new windows & doors to separate schedule

144 x 44 mm double hardwood rafters on 144 x 44 mm double hardwood bearer secret fixed to dwelling Pergola to be treated and finished with dark staining. Walls to plastered and painted to match existing.

Paving:
Laterite brick to be used for parking area. Red

GENERAL NOTES:

AND ARCHITECT.

ALL MATERIALS AND CONSTRUCTION MUST COMPLY WITH THE NATIONAL BUILDING REGULATIONS (ACT NO 103 OF 1977) INCLUDING ALL AMENDMENTS AS WELL AS THE BY-LAWS OF THE LOCAL AUTHORITIES.

ALL DIMENSIONS TO BE CHECKED ON SITE AND DRAWINGS MUST NOT BE SCALED.

ANY INDISTINCTNESS OR DISCREPANCIES MUST IMMEDIATELY BE POINTED OUT TO THE ARCHITECT FOR RECTIFICATION OR EXPLANATION BEFORE ANY CONSTRUCTION CAN COMMENCE.

GLAZING TO COMPLY WITH NBR PART N GEYSER TO COMPLY WITH SANS 0254 WOOD TO

COMPLY WITH SANS 0163 LEVELS AND STEPS TO BE DETERMINED ON SITE BY CONTRACTOR. TO BE APPROVED BY CLIENT

WHERE DRAINAGE OCCURS UNDER ANY PART OF A BUILDING, FOUNDATIONS MUST BE REINFORCED ACCORDING TO ENGINEER'S SPEC AND TO NBR REGULATIONS.

SANS 10400-A

197.98m²

2. STRUCTURAL DESIGN TO COMPLY WITH:	SANS 10400-B
3. DIMENSIONS TO COMPLY WITH:	SANS 10400-C
4. PUBLIC SAFETY TO COMPLY WITH:	SANS 10400-D
5. SITE OPERATIONS TO COMPLY WITH:	SANS 10400-F
6. EXCAVATIONS TO COMPLY WITH:	SANS 10400-G
7. FOUNDATIONS TO COMPLY WITH:	SANS 10400-H
8. FLOORS TO COMPLY WITH:	SANS 10400-J
9. WALLS TO COMPLY WITH:	SANS 10400-K
10. ROOFS TO COMPLY WITH:	SANS 10400-L
11. STAIRWAYS TO COMPLY WITH:	SANS 10400-M
12. GLAZING TO COMPLY WITH:	SANS 10400-N
13. LIGHTING AND VENTILATION TO COMPLY WITH:	SANS 10400-O
14. DRAINAGE TO COMPLY WITH:	SANS 10400-P
15. NON-WATER-BORNE MEANS OF SANITARY DISPOSAL TO COMPLY WITH:	SANS 10400-Q
16. STORMWATER DISPOSAL TO COMPLY WITH:	SANS 10400-R
17. FACILITIES FOR PERSONS WITH DISABILITIES TO COMPLY WITH:	SANS 10400-S
18. FIRE PROTECTION TO COMPLY WITH:	SANS 10400-T
19. SPACE HEATING TO COMPLY WITH:	SANS 10400-V
20. FIRE INSTALLATION TO COMPLY WITH:	SANS 10400-W
21. ENERGY USAGE IN BUILDINGS TO COMPLY WITH:	SANS 10400-XA

BUILDING CLASSIFICATION: G1-OFFICES

1. GENERAL PRINCIPLES & REQUIREMENTS TO COMPLY WITH:

DESIGN POPULATION: 30 PERSONS

PARKING RATIO:4/100m² THEREFORE 8 PARKING SPOTS REQUIRED. 10 PARKING SPOTS PROVIDED- COMPLIES

GROSS LEASABLE AREA(GLA):

AREA SCHEDULE

2015.6m² Erf size: 590m² Total Existing Built Area: Proposed Built Area: 590m²

EXISTING TOTAL FLOOR AREA 590m² Main Building: 320m² Covered Veranda: 70m²

65m² Garage: Staff Dining and Entertainment Area/Rec room: 92m² 43m² Covered Patio:

EXISTING COVERAGE CALCULATION

Coverage 29.27%

Nikita van Zyl Registration Number: PSAT 247 512 65

COUNCIL DRAWINGS

Issued for MUNICIPAL approval 08/04/2025 I Issued for MUNICIPAL approval 18/03/2025 Date No. Revisions




NIKITA VAN ZYL | 0726248024 | info@archonmain.co.za 115 Hoofweg Road, Wellington, 7655

FRUITWORKS ALTERATIONS AND ADDITIONS TO EXISTING STRUCTURE, ERF 3432, 58 MAIN RD, PAARL Drawing title


ELEVATIONS Date Drawing no.


4172- 01

Scale on A1 As indicated 06/05/2025 Drawn 01 WAF/NVZ Checked

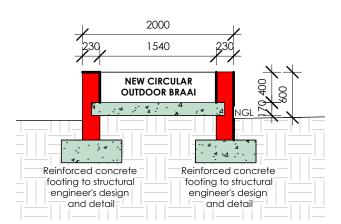


SECTION AA SCALE 1: 50

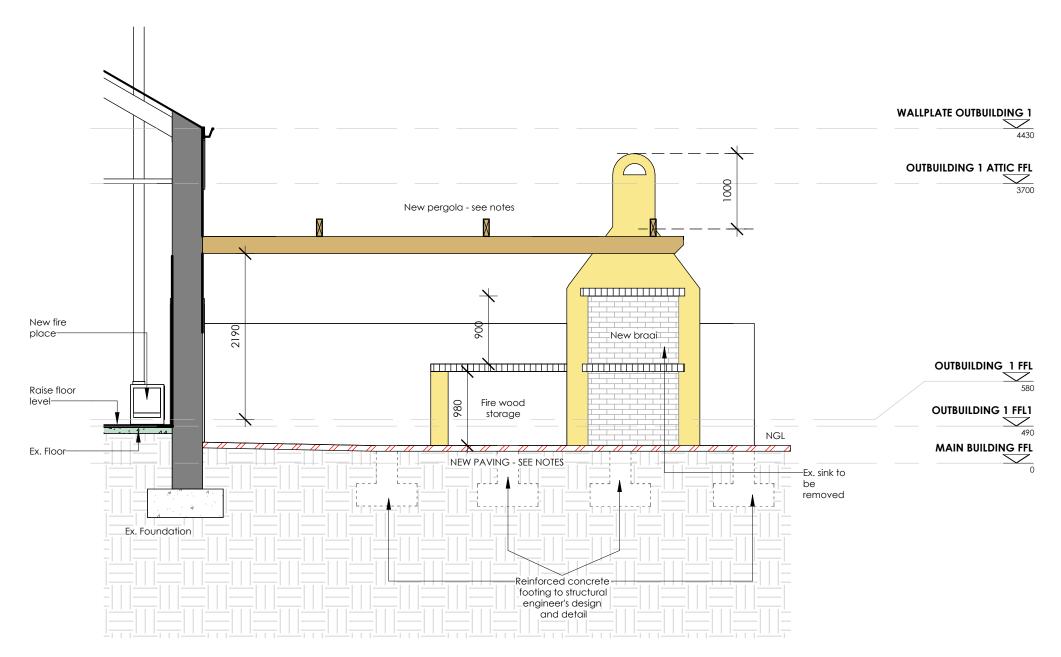


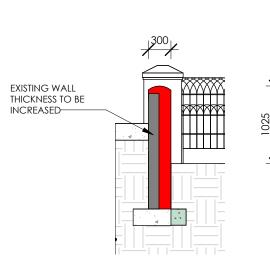

SECTION BB SCALE 1: 50

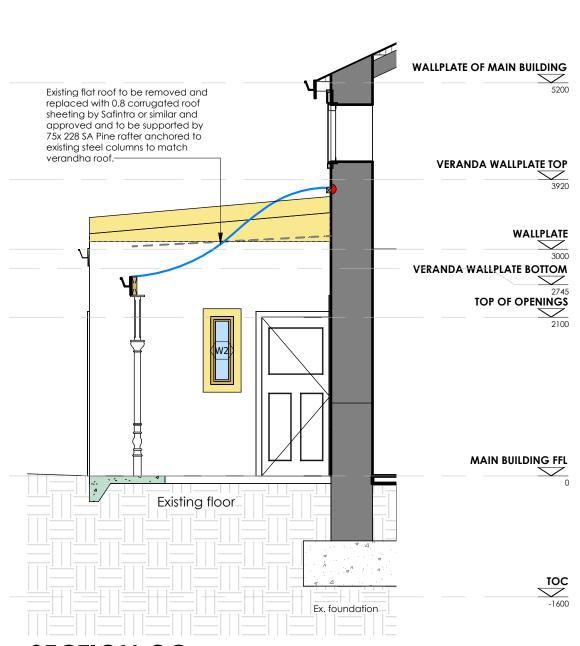

SECTION CC SCALE 1: 50

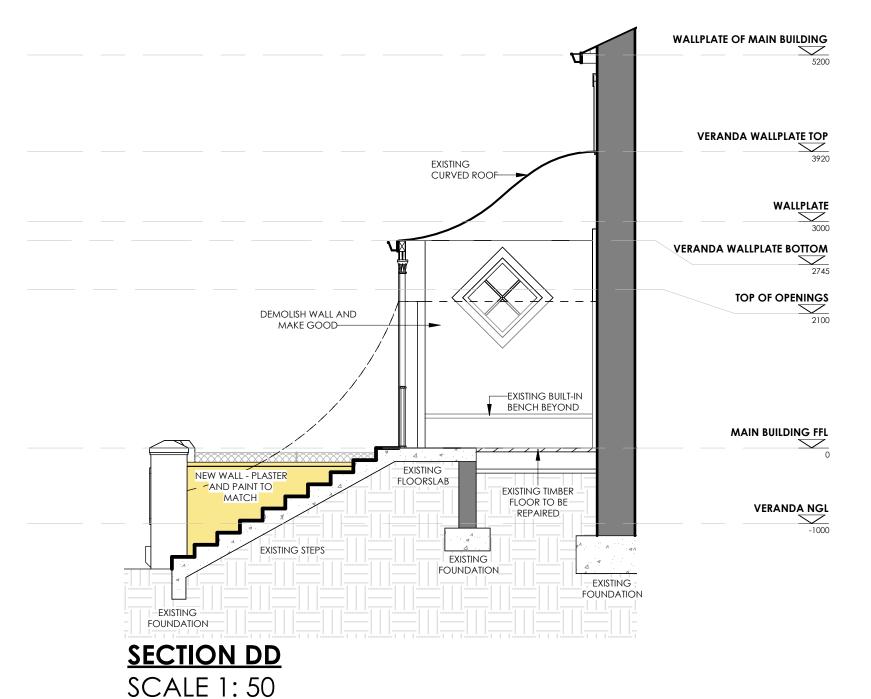

ENERGY DEMAND AND CONSUMPTION CALCS:

MINIMUM R-VALUE OF	PIPE INSULATION
1	2
Internal diameter of pipe mm	Minimum R-value*
≤80 >80	1,00 1,50
* Determined with a hot surface an ambient temperature of 15%	

Typical CR - Values

Typical Oil Value	3	
1	2	
Double brick	CR - Value	
wall type	h	
No cavity	40	
With 50mm air cavity	60	
With R = 0,5 cavity insulation	90	
With R = 1 cavity insulation	130	

HOT WATER SUPPLY NOTES:

Insulation required notes:

(Solar heating).
• Solar storage capacity -

Hot water demand - 4 persons

SANS10252 - 1 and SANS 10106

 $R - value = 1.00m^2 K/W$

The average population in new office: 20 person

Excluding 1 hour lunch.

Storage volume and heated power

Capacity of water heating insulation

Solar collector falt plate solar aevser

Regulation XA2 and XA4.1 have been met

All installations must be in accordance with

Required: Inter diameter of hot water pipes:

Insulation - combustible light weight fiberglass glasswool

with binding tape including 15mm x 20mm glasswool

Hot water demand and consumption: (as perpart XA of SANS 10400)

Average of 8 hours per day during the week.

Week days: 8hours x 5days = 40hours per week

Geyser insulation size 3500mm x 1200mm with edges sealed

Snap - on pipe insulation on all all hot and cold water pipes.

all in accordance with the manufacturers recomendations.

Assume that the office is occupied between 08:00 - 17:00 on week days.

10:00 for potential meetings. Average of 2 hours per day during the weekend.

Assume that on weekends the office is occupied between 08:00 -

2hours x 2days = 4hours per weekend

<80 mm = Min R- Value + 1.00 (SANS 204)

Provided isover 35mm thick gevser pipe

MINIMUM R-VALUE O	OF PIPE INSULATION
1	2
Internal diameter of pipe mm	Minimum R-value*
≤80 >80	1,00 1,50
* Determined with a hot surfa	ace temperature of 60°C and

i ypicai Oit - vaide	3	
1	2	
Double brick	CR - Value	
wall type	h	
No cavity	40	
With 50mm air cavity	60	
With R = 0,5 cavity insulation	90	
With R = 1 cavity insulation	130	

Note: The following types of masonry walling comply with the R-value a) double-skin masonry with no cavity, plastered internally, or rendered externally; or Note: The cavity and grouted cavity walling systems exceed the min R-value of 0,35. b) single-leaf masonry walls with a nominal wall thickness greater than or equal to 140mm (excl plastering and rendering), plastered internally.

TOTAL HOURS PER ANNUM: total hours per week(40h + 4h) x Weeks in a year(52) = 2288total days in a year(365) \times hours in a day(24) = 8760

total hours used per year / total hours per year :

2288/8760 = **0,26** CONSUMPTION:

> population in office x daily usage x capita - SANS(115L per day) 20 x 115L x 0.26 = <u>598</u>**L** of water a day needed @ 38° C

50% of hot water to be heated by means of other than electricity.

REQUIRED: Storage in excess of daily usage +50% 1.5 x <u>598</u> per day = <u>897</u>L required per day

PROVIDED :4 X 150L Apollo Solar Technology APIHP-15 Intregrated High Pressure Solar Geyser (150L) to be installed and connected to all water points. This heats up more than 50% of hot water required per day

More than 50% of heating by non-electrical resistance heating (which is greater than the minimum 50% required) = COMPLY

Solar to be supplied and installed all in accordance with manufacturers' to comply to SANS 60335-2, and SANS 1352.

INSULATION REQUIRED:

REQUIRED: Internal diameter of hot water pipes <80mm = min. required r-value = 1.00 PROVIDED: Isover 35mm thick geyser pipe insolation non-combustible light weight fibreglass Glasswoo geyser insulation size 3500mm x 1200mm with edges sealed with binding tape including 15

snap-on pipe insulation on all hot and cold water pipes, All in accordance with manufacturers recommendations.

R-value - 1.00m ² Minimum total R-values of roofs assemblies and levels of thermal insulation	
Energy zones	4
Minimum required total R-Value (m².K/W)	3,7
Direction of heat flow	Up
Minimum total R-value (m².K/W) of roof and ceiling materials (Roof covering includes outside air film, non-reflective unventilated air space and plasterboard only).	0,30 to 0,35
Estimated minimum added R-Value of insulation (m².K/W)	3,35
Product	Glass woo blanket
Density (kg/m³)	10 to 18
K-value (W/m.K)	0,040
Recommended levels (thickness in mm) of thermal insulation to be used equivalent to R-Value required. Thermal conductivity values used are generic.	135 mm

THEREFORE COMPLIES **FENESTRATION CALCULATIONS:**

TOTAL AREA FLOOR OF NEW DWELLING

1.5m²

17.15m²

WINDOW TOTAL -DOORS TOTAL -

> 20% OF TOTAL AREA = 88.5m3 TOTAL GLAZING =18.65m² LESS THAN 20%

DOES COMPLY WITH REGULATIONS

GENERAL NOTES:

FILLING MATERIAL: Filling materials under floor slabs to consist of suitable material and to be

compacted in layers of max. 150mm thick, to a density of at least 90%MOD AASHTO FOUNDATIONS:

Concrete in 1:3:6 mix to sizes as shown on drawings. Cement to be SABS ENV 197-1 strength class 32.5 and aggregate to SABS specification 1083. Continuous strip foundation to be minimum 250mm thick, unless laid on soli rock and min 750mm wide to load bearing or free standing walls or 400mm wide for non-loadbearing internal masonry walls.

FLOORS: Floor finish as described elsewhere on 30mm 3:1 sand:cement screed on 100mm 1:2:4 concrete slab on 250micron membrane on consolidated fill for groundfloor. Floorslabs to b

reinforced with BRC.245 weldmesh where depth of fill exceeds 1m. No ground floor slab to pass over or to be supported on foundation walls. FLOOR DAMP PROOFING: Under floor membrane to be Gunplus 250 micron membrane on 50mm sand blinding laye

to be laid on surface not containing sharp

objects and to be turned up around perimete

of and at least for full thickness of slab. Any joints will overlap 150mm min and will be effectively

sealed.

All bricks to comply to with SABS 227. External walls to be 280mm cavity walls with plastered and painted bricks where indicated. Internal walls to be 115/230mm walls with plastered and

painted bricks. Exterior walls to be painted WALL DAMP PROOFING:

Gunplas 375 micron to all walls stepped to outer

every 3rd brick. Vertical DPC to door, window cills and heads. No DPC to free standing walls.

skin of wall when a cavity wall. Wheepholes

Internal and external walls to receive smooth plaster finish.

Galvanized butterfly type every 4th course staggered at 1m c/c

PRECAST LINTELS: STRESSO lintels over all openings exceeding 1.5m with damp proof membrane stepped over Openings of more than 3.5m to be engineers's

BRICK REINFORCEMENT: Use galvanized brick force in first 5 courses

above foundation and 5 courses continuous above lintel height. ROOF SHEETING TO ENTIRE ROOF AREA:

Safintra 0.50mm thick Saflok 410® Colorplus® AZ 150 interlocking roof sheeting fixed to stee internal purlins at 1700mm centres, and idge/eaves purlins at 1500mm centres using Saflok 410® clips that must be fastened with Safintra approved wafer head self-tapping screws, all in accordance with manufacturer's recommendations. The sheeting will be a double interlocking concealed fix Saflok 410®

as manufactured by Safintra, roll-formed in continuous lengths from Aluminum or Aluminum-Zinc coated steel. Colour to be dar

charcoal.

Roof Anchor:

Roof 1: (Curved roof) 0.8 Corrugated Roof sheeting by Safintra or

similar and approved to be curved matching front veranda to be supported by 75x 228 SA Pine rafter anchored to existing steel columns

Trusses to be anchored min 760mm deep by 30 × 1,2 mm galvanized steel strap Ridge & side flashing to match colour of roof

sheeting. 135mm layer of Isotherm insulation or equivalent and approved to be applied to entire roof.

Vapour barrier HF 2 aluminum foil sisilation or equivalent to be laid directly under the roof

painted on 50x38mm battens spaced max

450mm cc

Detail of eaves to match existing dwelling

Rainwater goods: Fascias and bargeboards to be 225 x12mm "Everite Nutec" or similar approved medium density fibre cement board with plain finish, butt jointed and painted with high quality acrylic paint to match the roof colour. Seamless "Watertite" Aluminum or similar, approved standard domestic Ogee gutters wit round down pipes, powdercoated. "Everite" or

Window & Doors: All new windows & doors to separate schedule

144 x 44 mm double hardwood rafters on 144 x 44 mm double hardwood bearer secret fixed to dwelling Pergola to be treated and

finished with dark staining. Walls to plastered are painted to match existing.

similar approved plain fibre cement fascia,

Paving:
Laterite brick to be used for parking area. Red brick to be used for braai area.

GENERAL NOTES:

ALL MATERIALS AND CONSTRUCTION MUST COMPLY WITH THE NATIONAL BUILDING REGULATIONS (ACT NO 103 OF 1977) INCLUDING ALL AMENDMENTS AS WELL AS THE BY-LAWS OF THE LOCAL AUTHORITIES.

ALL DIMENSIONS TO BE CHECKED ON SITE AND DRAWINGS MUST NOT BE SCALED.

ANY INDISTINCTNESS OR DISCREPANCIES MUST IMMEDIATELY BE POINTED OUT TO THE ARCHITECT FOR RECTIFICATION OR EXPLANATION BEFORE ANY CONSTRUCTION CAN COMMENCE.

GLAZING TO COMPLY WITH NBR PART N GEYSER TO COMPLY WITH SANS 0254 WOOD TO COMPLY WITH SANS 0163

LEVELS AND STEPS TO BE DETERMINED ON SITE BY CONTRACTOR. TO BE APPROVED BY CLIENT AND ARCHITECT.

WHERE DRAINAGE OCCURS UNDER ANY PART OF A BUILDING, FOUNDATIONS MUST BE REINFORCED ACCORDING TO ENGINEER'S SPEC AND TO NBR REGULATIONS.

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BUILDING CLASSIFICATION: G1-OFFICES

|DESIGN POPULATION: 30 PERSONS

PARKING RATIO:4/100m² THEREFORE 8 PARKING SPOTS REQUIRED. 10 PARKING SPOTS PROVIDED- COMPLIES

197.98m² GROSS LEASABLE AREA(GLA):

2015.6m²

43m²

AREA SCHEDULE Erf size:

Covered Patio:

Total Existing Built Area: 590m² 590m² Proposed Built Area: 590m² **EXISTING TOTAL FLOOR AREA:** 320m² |Main Building: 70m² Covered Veranda: 65m² Garage:

Staff Dining and Entertainment Area/Rec room: 92m²

EXISTING COVERAGE CALCULATION Coverage 29.27%

Nikita van Zyl Registration Number: PSAT 247 512 65

COUNCIL DRAWINGS

Issued for MUNICIPAL approval 08/04/2025 I Issued for MUNICIPAL approval 18/03/2025 Date No Revisions



NIKITA VAN ZYL | 0726248024 | info@archonmain.co.za 115 Hoofweg Road, Wellington, 7655

FRUITWORKS


ALTERATIONS AND ADDITIONS TO EXISTING STRUCTURE, ERF 3432, 58 MAIN RD, PAARL

Drawing title Scale on A1 SECTIONS Drawing no. Drawn 4172- 02 03 Checked

WAF/NVZ

As indicated

06/05/2025

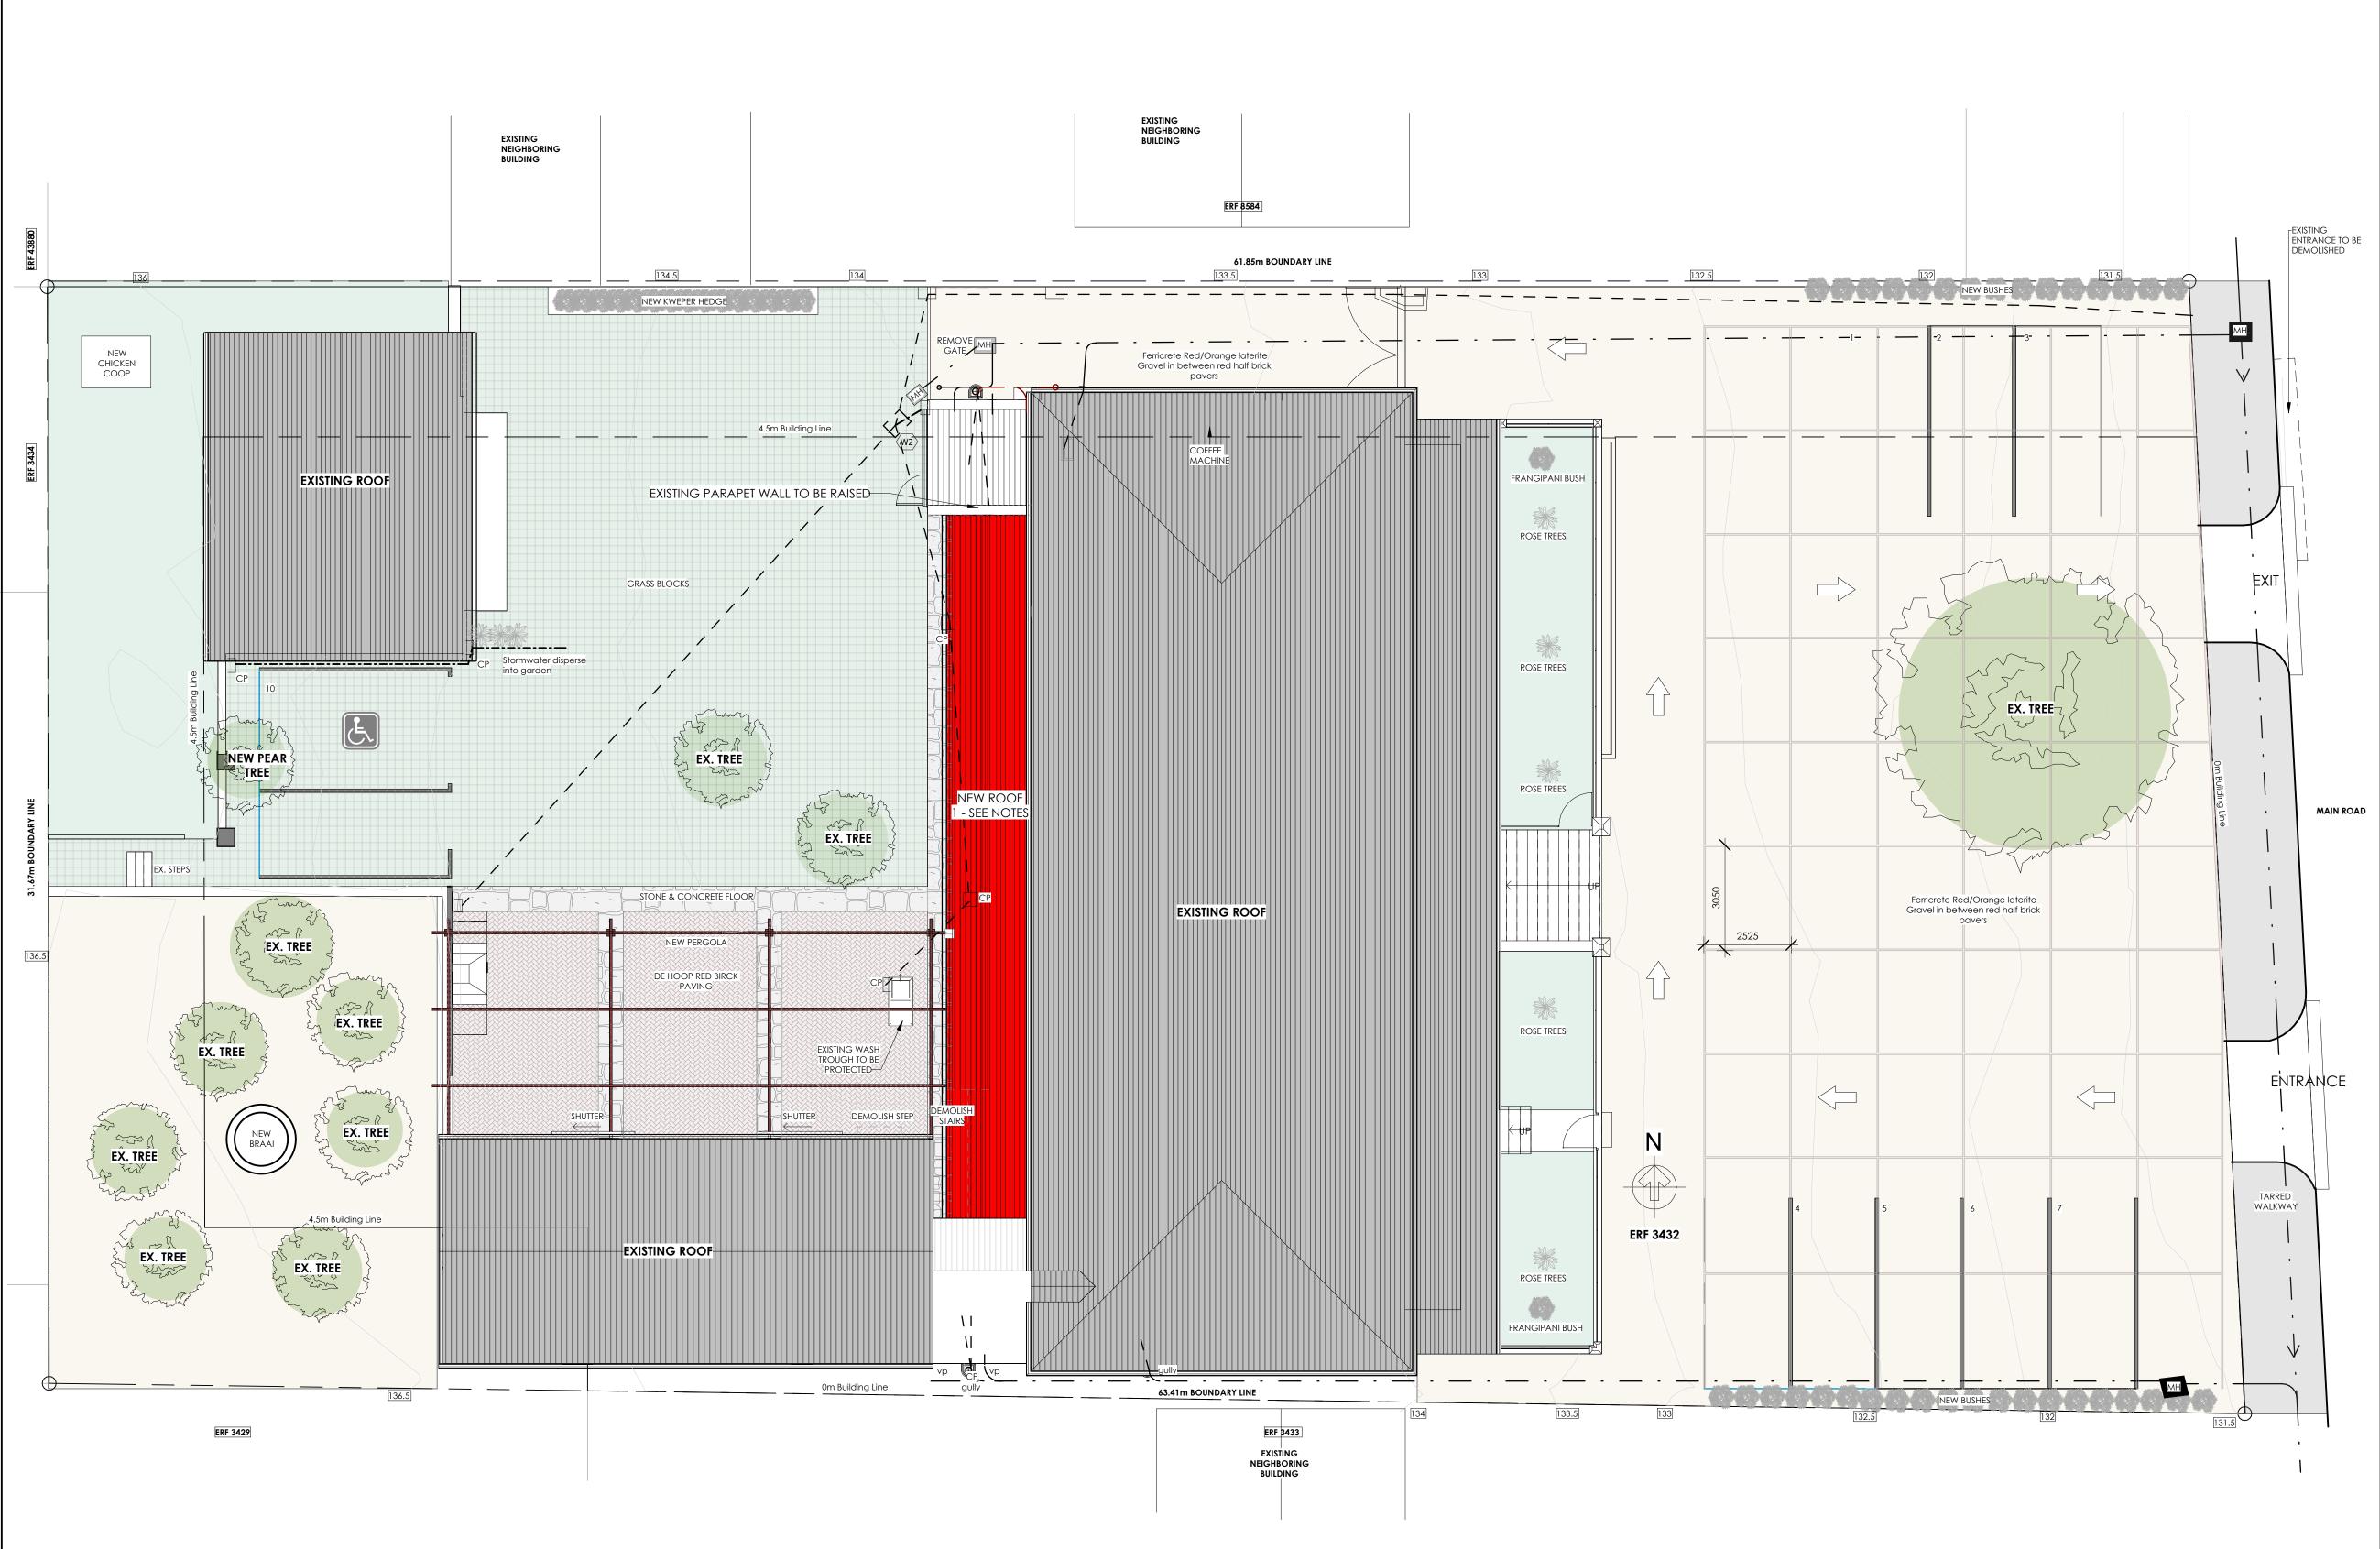

ROOF PLAN SCALE 1: 100

> 197.96²m 12.89²m 22.41²m 23.07²m 65.90²m 26.52²m 14.25²m 14.20²m 18.74²m GROSS LEASABLE AREA(GLA): Office 2 Board Room Reception 2 Open Work Area Office 1 Reception 1 Finance Total gross Leasable Are

GENERAL NOTES:

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197.98m² GROSS LEASABLE AREA(GLA):

AREA SCHEDULE

2015.6m² Erf size: Total Existing Built Area: 590m² Proposed Built Area: 590m²

EXISTING TOTAL FLOOR AREA: 590m² 320m² Main Building: Covered Veranda: 70m² Garage: 65m ² Staff Dining and Entertainment Area/Rec room: 92m²

43m ²

EXISTING COVERAGE CALCULATION

Coverage 29.27%

Covered Patio:

Professional. Nikita van Zyl Registration Number: PSAT 247 512 65

COUNCIL DRAWINGS

02 Issued for MUNICIPAL approval 08/04/2025 18/03/2025 01 Issued for MUNICIPAL approval Date



NIKITA VAN ZYL | 0726248024 | info@archonmain.co.za 115 Hoofweg Road, Wellington, 7655

As indicated

Drawn


Checked


06/05/2025

WAF/NVZ

FRUITWORKS ALTERATIONS AND ADDITIONS TO EXISTING STRUCTURE, ERF 3432, 58 MAIN RD, PAARL Drawing title Scale on A1 ROOF PLAN

Drawing no. 01 4172- 03

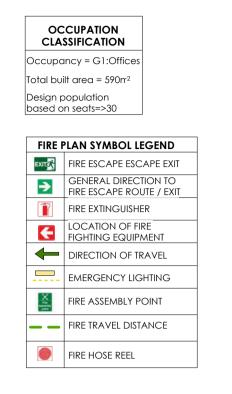

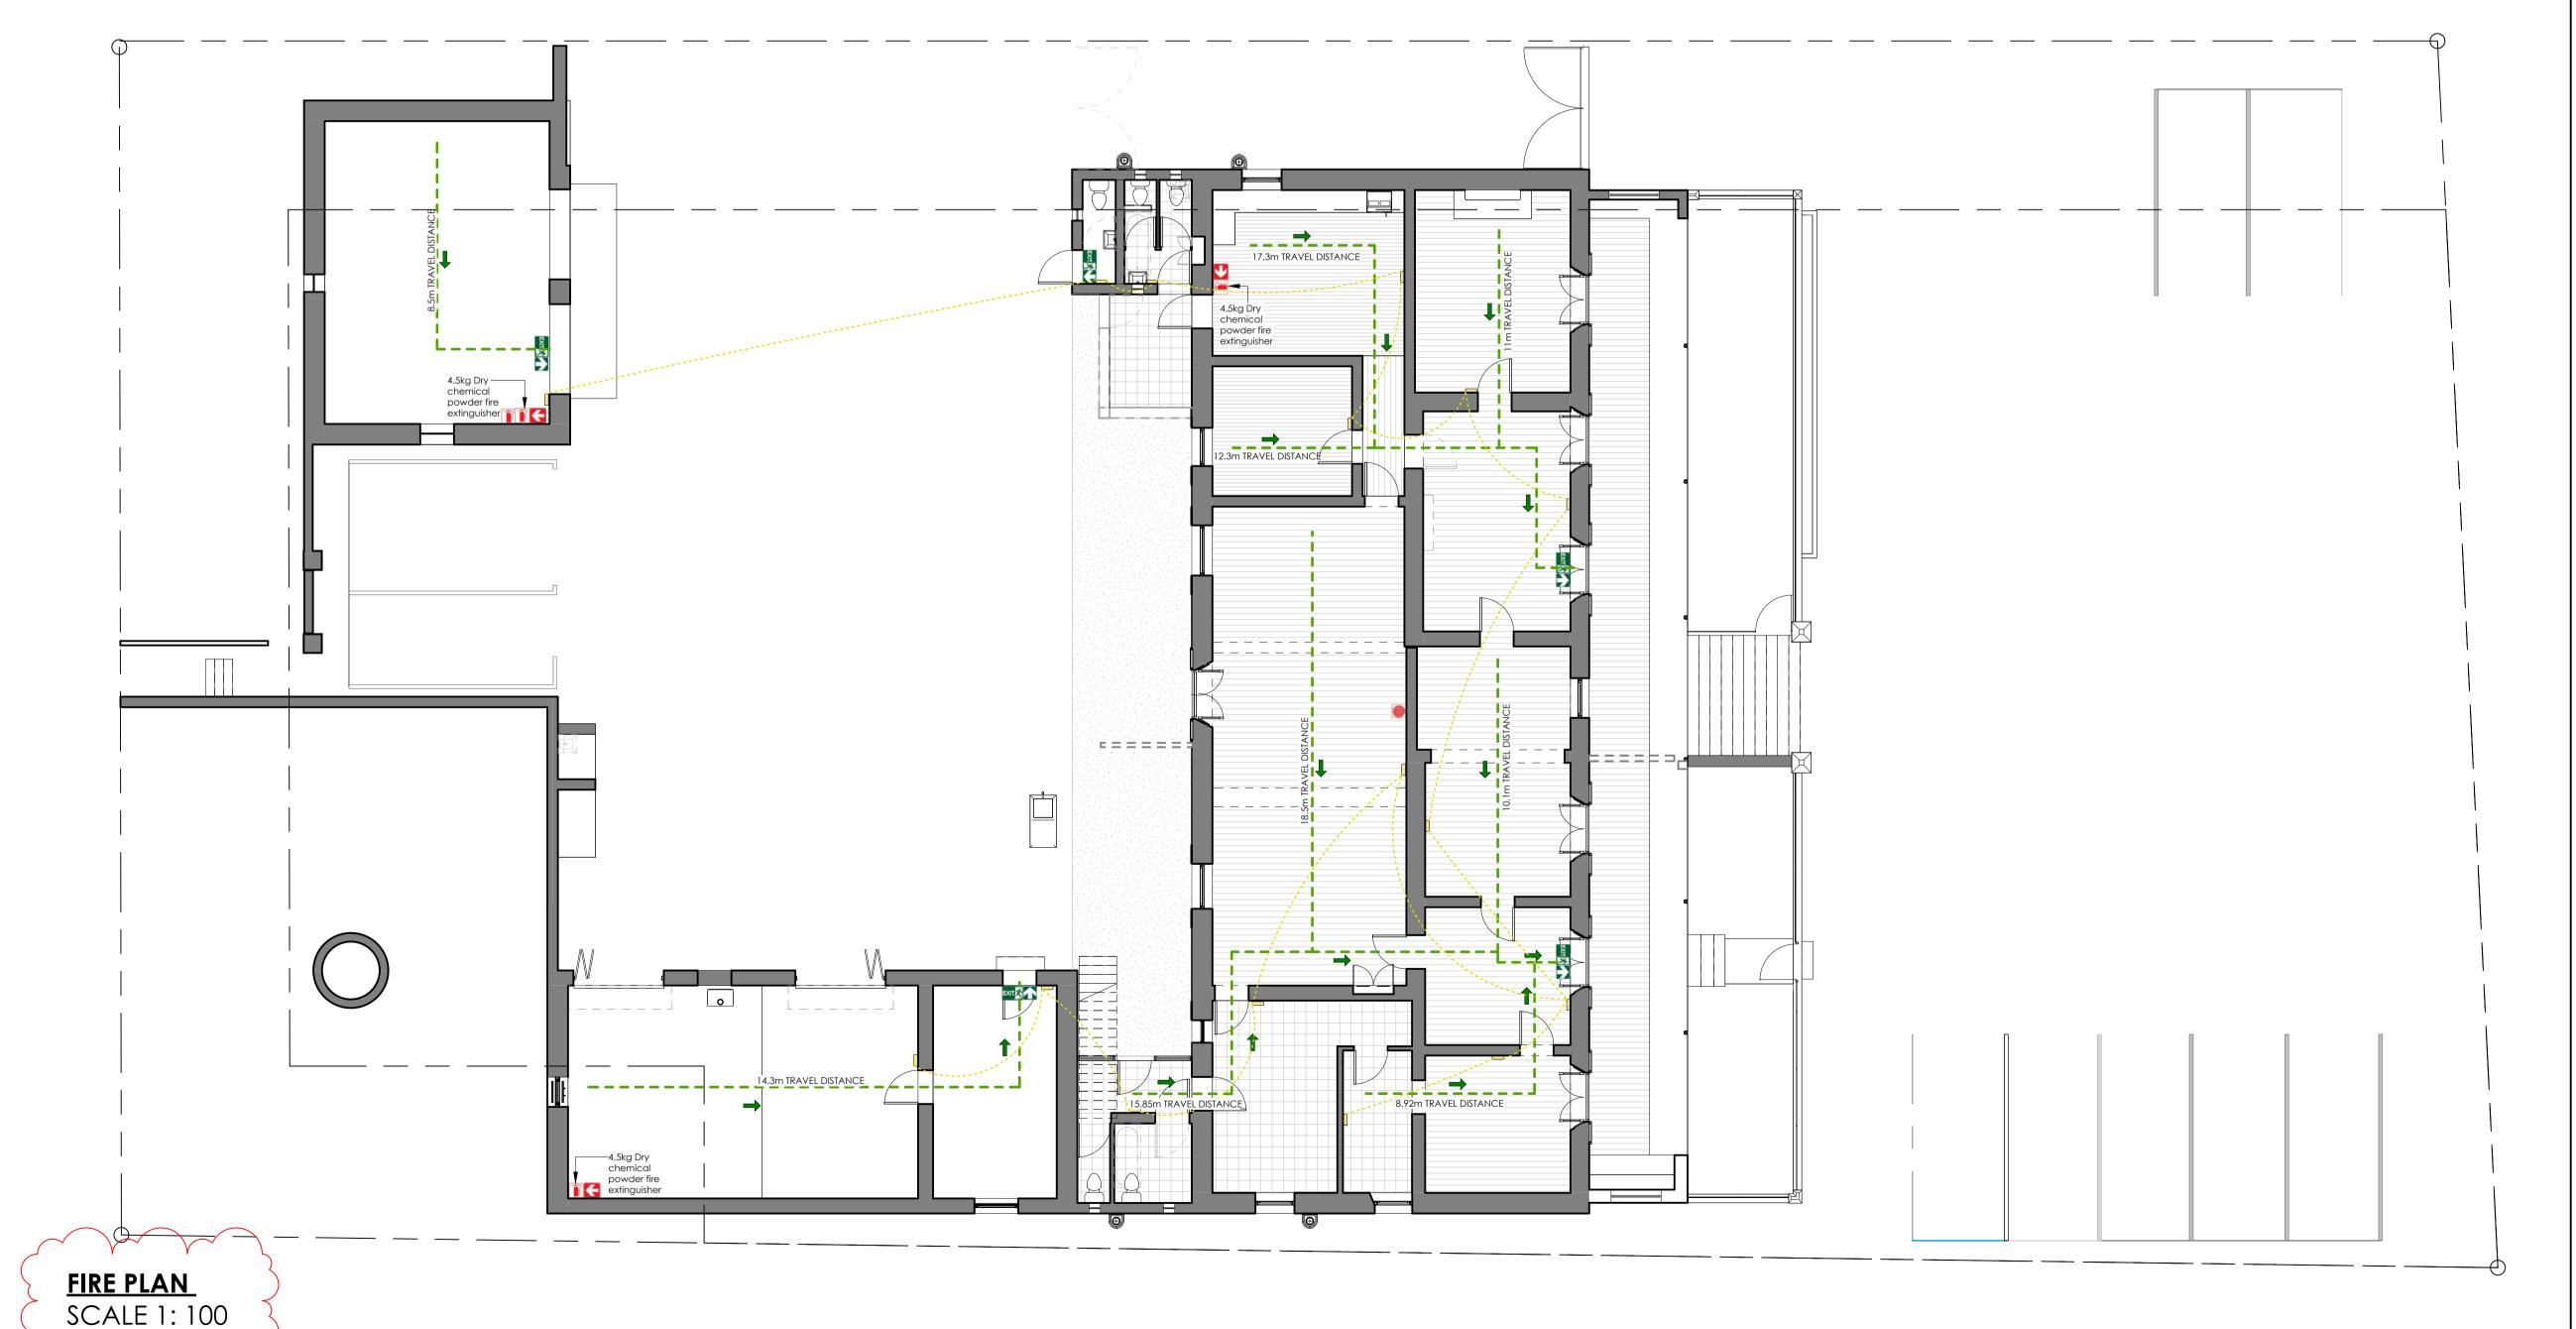

GENERAL NOTES:

ALL MATERIALS AND CONSTRUCTION MUST COMPLY WITH THE NATIONAL BUILDING REGULATIONS (ACT NO 103 OF 1977) INCLUDING ALL AMENDMENTS AS WELL AS THE BY-LAWS OF THE LOCAL AUTHORITIES.

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AREA SCHEDULE 2015.6m² Total Existing Built Area: 590m² 590m² Proposed Built Area:

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EXISTING COVERAGE CALCULATION

Coverage 29.27%

Covered Patio:

Professional. Nikita van Zyl Registration Number: PSAT 247 512 65 Myl

COUNCIL DRAWINGS

02 Issued for MUNICIPAL approval01 Issued for MUNICIPAL approval 08/04/2025 18/03/2025 Date



NIKITA VAN ZYL | 0726248024 | info@archonmain.co.za 115 Hoofweg Road, Wellington, 7655

FRUITWORKS

ALTERATIONS AND ADDITIONS TO EXISTING STRUCTURE, ERF 3432, 58 MAIN RD, PAARL

Scale on A1

Checked

As indicated

08/04/2025

WAF/NVZ

Drawing title SITE AND FLOOR PLAN Drawing no. 4172- 04



www.drakenstein.gov.za

□ customercare@drakenstein.gov.za

Civic Centre, Berg River Boulevard, Paarl 7646



То:	EXECUTIVE DIRECTOR: CORPORATE & PLANNING SERVICE (ATTENTION: C. VAN DER BANK)
From:	EXECUTIVE DIRECTOR: ENGINEERING SERVICES
Enquiries:	LH. SMITH
Collaborator number:	2255828
Reference number:	15/4/1 (3432) P (0980)
Date:	31 July 2025
Subject:	APPLICATION FOR REZONING, DEPARTURE OF DEVELOPMENT PARAMETERS AND APPROVAL OF SITE DEVELOPMENT PLAN: ERF 3432, PAARL

These conditions will be subject to review by the Engineering Services Department upon receipt of Civil and/or building plans for approval. This may require all the studies carried out for the proposed development to be updated and revised accordingly, which shall include compliance with the latest legislation, amended legislation, latest or amended standards and revised master planning.

The aforementioned is based on the possibility of changes in the physical environment in respect of engineering infrastructure between date of issuing of conditions and actual building/construction being imminent, which may impact on available relevant infrastructure capacities as at time of initial issuing of conditions.

NOTE: This comment covers a number of disciplines and each section needs to be dealt with by a competent specialist in that field co-ordinated by the consultant managing the application. No correspondence will be entered into with individual consultants.

THE FOLLOWING CONDITIONS WILL APPLY

1 STREETS & TRAFFIC

- 1.1 Any new roads/streets and accesses will be the responsibility of the developer, including all internal and bulk connectors;
- 1.2 Any alterations to the existing road network will be the responsibility of the developer which includes design, approval and construction of any additional traffic control and or traffic calming measures as per Traffic Impact Assessment (TIA) dated March 2025, Rev 01; and
- 1.3 It should be noted by the Developer that the proposed access configuration is not to standard in terms of the Western Cape Provincial Access Management Guidelines but is similar to neighbouring properties. This may result in difficulties entering and exiting the property.

2 STORM WATER

- 2.1 A Stormwater Management Plan (SWMP) must be submitted for approval to the Engineer: Roads and Stormwater prior to any building and/ or civil plan approval;
- 2.2 Any new storm water networks will be the responsibility of the developer, including all internal and bulk connectors;
- 2.3 Only pre-development run-off of a 1:2 year storm event will be accepted into the existing system. Provision must be made to accommodate the detention of run-off for a 1:50 year storm event; and
- 2.4 Provision must be made for an effective rainwater harvesting system to be planned and designed for all roof water. The volume of the storage facilities should be based on 0.02m³/m² roof area.

3 WATER

- 3.1 The existing water metered connection for the development shall remain;
- 3.2 Water saving devices shall be installed in toilets, bathrooms and basins; and
- 3.3 Any existing system that is to remain shall be upgraded to minimum municipal standards.

4 WASTEWATER SERVICES

- 4.1 The existing wastewater connections for the development shall remain; and
- 4.2 Any existing system that is to remain shall be upgraded to minimum municipal standards.

5 SOLID WASTE

- 5.1 The Municipality undertakes to remove household refuse in accordance with its by-laws;
- 5.2 Such refuse collection will be provided as a kerbside service;
- 5.3 A waste recovery/recycling initiative has been implemented in Drakenstein and the development will have to be prepared to comply with any requirements as the project is rolled out.

6 DEVELOPMENT CHARGES

6.1 Based on the information provided in the application, the Development Charge payable by the developer is **R 62 526.00 (Excl VAT)**. The levy is valid until **30 June 2026** where after a new calculation is required. The value has been calculated as follows:

- 6.1.1 Water = R 0.00
- 6.1.2 Sewer = R 0.00
- 6.1.3 Roads = R 55,104.00
- 6.1.4 Stormwater = R 4.932.00
- 6.1.5 Solid Waste = R 2,489.00

7 GENERAL

- 7.1 Depending on the scale of expansion in future, additional Civil Engineering Specialist Reports may be requested by this department when the developer wishes to increase the GLA;
- 7.2 The developer is responsible for the payment of a Developers Charge (water, sewer, stormwater, solid waste and roads) which can be discounted against the bulk service cost needed for the development;
- 7.3 The developer is responsible for the funding of all connections to the bulk services and all internal works;
- 7.4 All of the works, including but not limited to; roads, stormwater, water, sewers, landscaping, irrigation, etc. shall be designed by a suitably registered (ECSA registration for the civil works and SACLAP registration for the landscaping) person and any such works shall be constructed under supervision of such registered person. All such design plans shall be submitted to the Civil Engineering Services Department of Drakenstein Municipality for approval prior to the commencement of construction;
- 7.5 All works where applicable shall be constructed to at least the minimum standards as set out in, Engineering Services: Municipal Standards;
- 7.6 A set of accurate as-built drawings as per Drakenstein Municipality: Civil Engineering Department's Standards must be submitted at the practical completion inspection; and
- 7.7 The above conditions are to be complied with in stages.
 - 7.7.1 Requirements associated with the preparation of plans, drawings, permits, agreements and approvals, shall be complied with prior to construction;
 - 7.7.2 Requirements associated with the completion of construction, development charges, as-built drawings, maintenance management plans, agreements, etc. These will be complied with prior to the transfer of any subdivided erf within the development property or occupation of any property/building in the phase; and

7.7.3 Proof of compliance for the requirements associated with long term operations must be available on request.



SENIOR MANAGER: INFRASTRUCTURE MANAGEMENT

I:\INFRASTRUCTURE MANAGEMENT\DEVELOPMENT APPLICATIONS\15 town planning\15-4-1\2025\Comments\Erf 3432, Paarl - Application for Rezoning, and Approval of SDP.docx LHS/bb

A city of excellence																
Err Number of Development: Physical Address: Municipal Area: Municipal Valuation of Property: Owner: Owner ID No:	ť.	3432 ; 88 Main Road Paarl, Mbekwini, Wellington R 8 035 000 Fruitworks Pty Ltd	, Main Road ni, Welling Ltd	•	Paarl	7646	7									
				THE REAL PROPERTY.		CAL	CULATED EXI	CALCULATED EXISTING DEMAND	ND			EXIST	EXISTING DEVELOPMENT CHARGE PER SERVICE	ARGE PER SERVICE		
Land Use		Unit	Usage	Land Area developed with	Water (kL/ day)	Sanitation (kL/day)	Stormwater (c.ha)	Solid Waste (tonnes/wk)	Solid Waste Roads (tonnes/wk) (trips/pk hr)	Electricity (kVA)	Water	Sanitation	Stormwater	Solid Waste	Roads	Electricity
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				AP	APPLICABLE CREDITS (%) APPLICABLE CREDITS (R)	%) R)					0% Ro
	TOTAL	L DEVELOPM	TOTAL DEVELOPMENT CHARGE PAYABLE (EXCLUDING VAT)	AYABLE (EXC	LUDING VAT) WAT(15510)						R 62 526 R 9379
Application Processed by:	TO Bradle	TOTAL DEVEL	OPMENT CHA	ARGE PAYAB	TOTAL DEVELOPMENT CHARGE PAYABLE (INCLUDING VAT)	F	Single Residential stand area > Soomz(Med/ High	o.		0	R 71 905
Signature:	81	18-Jul-25				Description of existing Existing House land use	Existing House	0.	0		0
Payment Received (R):		***************************************	***************************************				Office	Road Reserves	0	0	0

	Existing building for Office	#REF!	Parking Bays		
	0	0	0	0	0
Description of					
proposed land use					
	<u> </u>				

Date Payment Received:

ANNEXURE E



♀+27 21 807 4500 ♣ +27 21 872 8054
 ★ www.drakenstein.gov.za
 ☑ records@drakenstein.gov.za
 ♀ Civic Centre, Berg River Boulevard, Paarl 7646

Memo

То:	Senior Manager: Land Development Management
	For attention: H Strijdom/C van der Bank/E Cyster
From:	Manager: Planning and Customer Services
Enquiries:	L Laing
Reference number:	8/2/5_3432
Date:	11 March 2024
Subject:	APPLICATION FOR REZONING

Time Limit on Conditions: These conditions will be limited to a period of one (1) year from the date as on the covering memo from this department. After this period a re-application must be submitted for approval by this department.

- 1. INFORMATION REQUIRED/OUTSTANDING
 - 1.1. None.
- 2. THE FOLLOWING CONDITIONS WILL APPLY
 - 2.1. Only one service cable connection per erf is allowed.
 - 2.2. No trees or any type of structures may be erected under or near any new or existing electrical infrastructure.
 - 2.3. All electrical equipment shall comply with Drakenstein Municipality standards and have twenty-four-hour access for maintenance purposes.
 - 2.4. The developer will be responsible for all cost in the case where he or she request any infrastructure situated in the road reserve to be moved or relocated to new proposed positions.
 - 2.5. The developer is required to include measures to improve energy efficiency for any additional load requirement to the existing electrical supply.
 - 2.6. A service level agreement between the municipality and the owner or developer of above-mentioned erf must be arrange at Electro-Technical Service Department (Planning and Design division Chief Engineering Technician) in the case where a request for the change and or upgrade of the existing supply is required.

3. GENERAL

- 3.1. NRS069 Network recovery cost will apply for any additional load requirement and will be calculated according to the following as indicated in approved tariffs: **R4 317.00 per kVA (V.A.T. included)**. The cost as mentioned above is valid until 30 June 2024 and will escalate thereafter for each upcoming financial year which is between 1 July and 30 June.
- 3.2. The developer will be responsible to carry all cost of the electrical installation.
- 3.3. All upgrade and service costs must be paid at the Finance Services Department in cash before any service connection may be rendered.
- 3.4. A private registered electrical installation electrician shall be used to do all installations and alterations according to SANS 10142, Occupational Health and Safety Act (Act 85 of 1993) and Drakenstein Municipal by-laws prior to the development.
- 3.5. A certificate of compliance and occupational certificate must be handed over to the Electro-Technical Services Department (Service section) on the day the service is rendered or as the case may be.
- 3.6. The Manager: Planning and Customer Services with reference to the services and conditions has no objection to this application.

Yours faithfully

L LAING

MANAGER: PLANNING AND CUSTOMER SERVICES

 $I: BEPLAN_3 \setminus Sub_Divisions_Rezoning \setminus 202324 \setminus 3432$